
Subject To Field Inspection

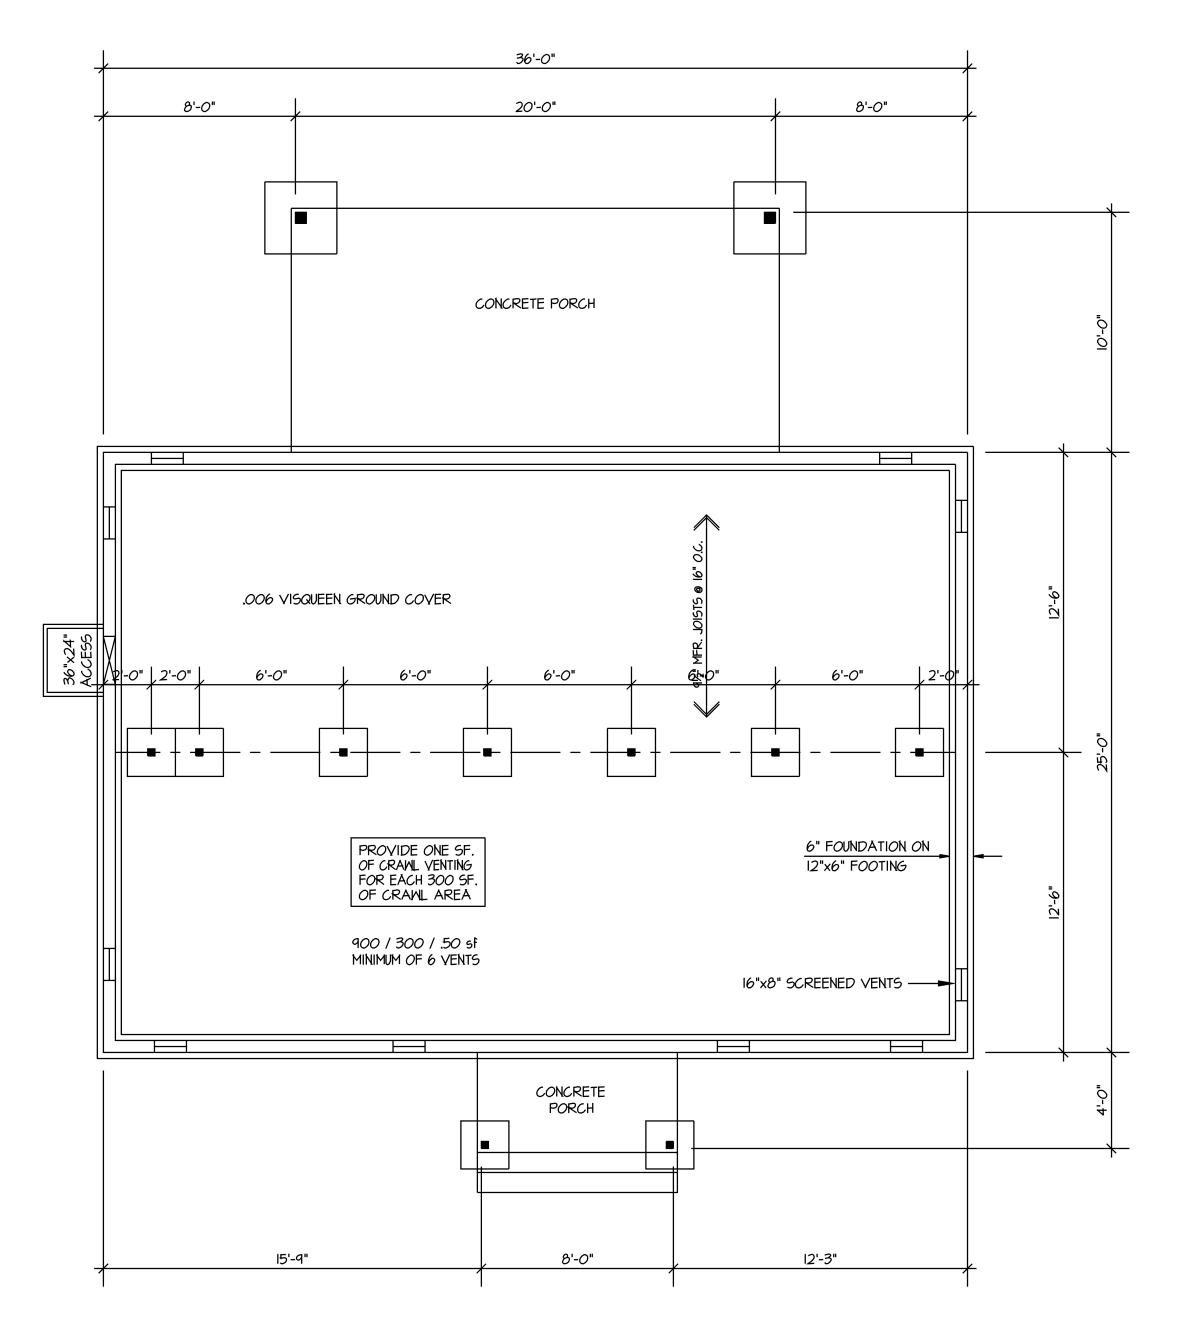


See Engineered Plans

FOUNDATION PLAN

4" = 1'-0"

CHANGES
MUST Be Approved Prior
To Performing Work

Validity of permit. The issuance or granting of a permit shall not be construed to be a permit for, or an approval of, any violation of any of the provisions of the International Codes or any other ordinance of Kitsap County. Permits presuming to give authority to violate or cancel the provisions of the International Codes and ordinances of Kitsap County shall not be valid. IBC & IRC 105

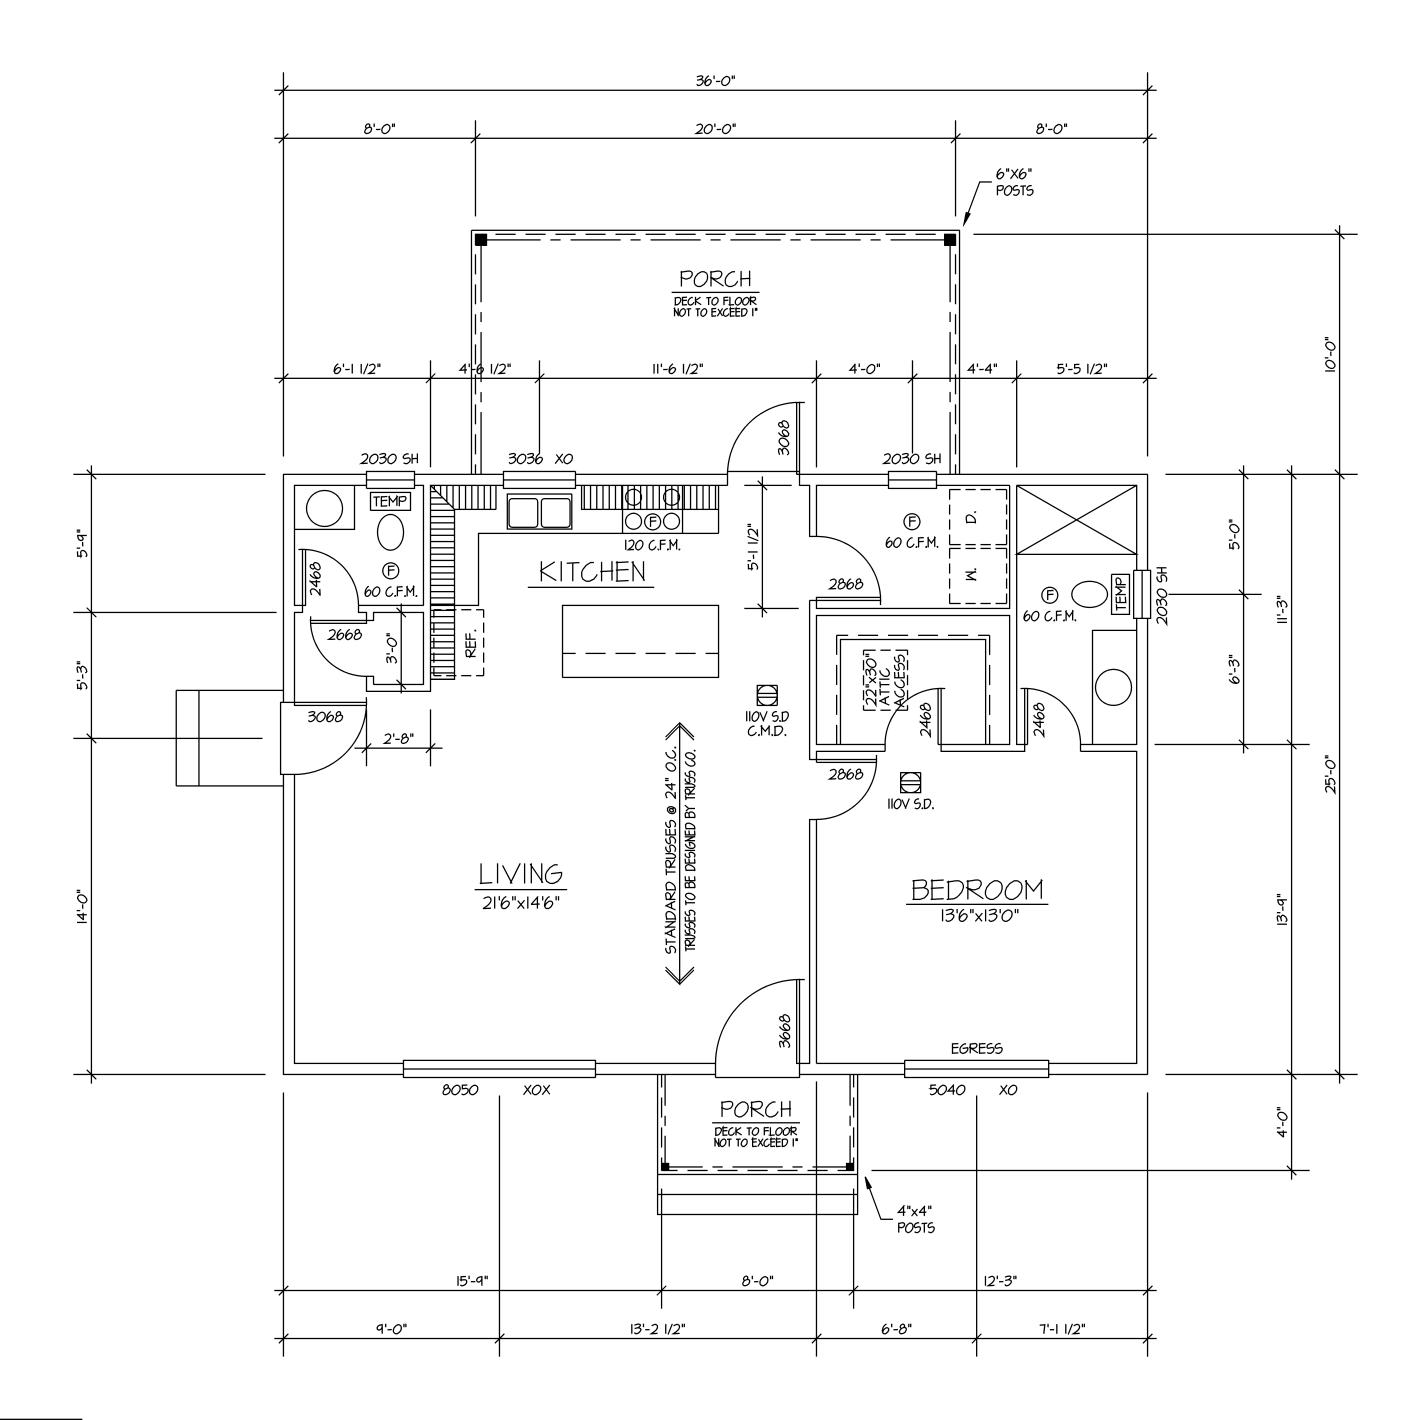

ENERGY NOTES:

LAVATORY FAUCETS = 1 G.P.M.

SHOWER HEADS

TUB AND KITCHEN SINK = 1.75 G.P.M.

SEE ENGINEERING FOR MORE INFORMATION IF THERE IS A CONFLICT THE ENGINEERING PLANS TAKE PRECEDENCE Smoke & carbon monoxide detectors required.

Smoke and carbon monoxide detectors must be installed throughout the building in all locations required by the IRC as amended by WAC.

FLOOR PLAN

4" = 1'-0" 900 SQ. FT.

REAR PORCH 200 SQ. FT.

FRONT PORCH 32 SQ. FT.

PLAN IS DRAWN:
2015 I.R.C. CODE, WAC 51-15 (CHAPTERS 1-10, 12-24,APPENDIX 6 & R)
2015 WASHINGTON ENERGY CODE, WAC51-11
2015 UNIFORM PLUMBING CODE, WAC 51-56 AND 51-57
2015 UNTERNATIONAL MECHANICAL CODE
2015 INTERNATIONAL FUEL CODE, WAC 51-52

Reviewed for code compliance

With IRC 2015

With IRC 2015

Building Department

Sc.

Drawn:

PQuiriar @co.kitsap.wa.us

Drawn:

Job:

Must Comply With All Washington State Codes





PROVIDE I" DRIP EDGE AT ALL EAVES & GABLES - MFG. TRUSSES @ 24" O.C. - COMPOSITION ROOFING ・ %" OSB SHEATHING — 15# BUILDING PAPER - YENT BLOCKING Gutters and downspouts are required.

All roof and yard drains shall be directed to splash blocks at a minimum, or to an infiltration system if required. All surface drainage shall have a minimum 2% grade away from the foundation. NR-49 INSULATION - CONTINUOUS GUTTER — % G.M.B. 4"xIO" HEADERS W/ R-10 FOAM INSULATION - R-21 INSULATION 1/6" OSB SHEATHING LAP SIDING HOUSE WRAP - R-38 INSULATION / 9½" MFR. JOISTS @ 16" O.C. — 2"x6" STUDS @ 16" O.C. 34" OSB T&G LAP SIDING 2"x6" P. T. SILL W/ %" J-BOLTS 4"x4" POSTS - 4" DOWNSPOUT / ROOF DRAIN - 4" FOOTING DRAIN SEE ENGINEERING FOR MORE INFORMATION IF THERE IS A CONFLICT THE ENGINEERING PLANS TAKE PRECEDENCE REAR ELEVATION RIGHT ELEVATION 1₄" = 1'-0" 1/4" = I'-O" CROSSECTION ATTIC YENTING: 1132 sf / 300 MINIMUM OF 3.8 sf REQUIRED HALF AT TOP AND HALF AT BOTTOM 1/2" = 1'-0"

> 12 26.5° 6

> > LEFT ELEVATION

1/4" = 1'-O"

PROVIDE I' DRIP EDGE
AT ALL EAVES 1 GABLES

CONTINUOUS RIDGE VENT

LAP SIDING

FRONT ELEVATION
4" = 1'-0"

