

BUILDING CODE DESIGN DATA

2015 IRC, WAC 51-51 2015 IFC, WAC 51-54A 2015 WSEC, WAC 51-11 2015 UPC, WAC 51-56 \$ 51-57 2015 IMC, WAC 51-52 2012 IFGC, WAC 51-52

GROUND SNOW LOAD: 30 lbs HOUSE FLOOR LOAD: 40 lbs DECK FLOOR LOAD: 60 lds (FLOOR DEAD LOAD: 15 lbs) WIND SPEED: 110 mph / 85 mph WIND EXPOSURE B SEISMIC: D2 FROST LINE: 12"

INDEX


AI FLOOR PLANS A2 ELEVATIONS SI FOUNDATION & FRAMING PLANS DI STRUCTURAL DETAILS

MAILING: 8018 WENATCHEE PL NW SILVERDALE, WA 98383 TAX ID# 4423-014-001-0100 DRAWN BY SCOTT SHELTON PLANSGUY® OUTLOOK.COM (360)620-8883 c DATE 12/17/19 REVISED


LOT / OWNER

DRAWING: FLOOR


PLANS

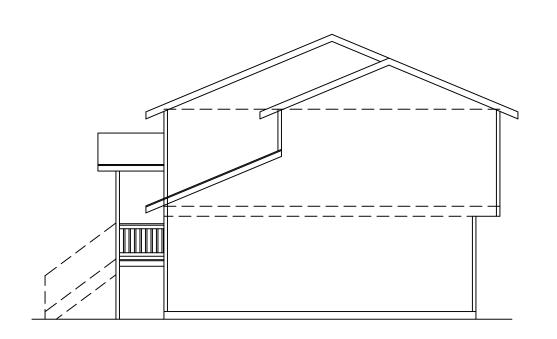


RIGHT ELEVATION SCALE: 1/8" = 1'

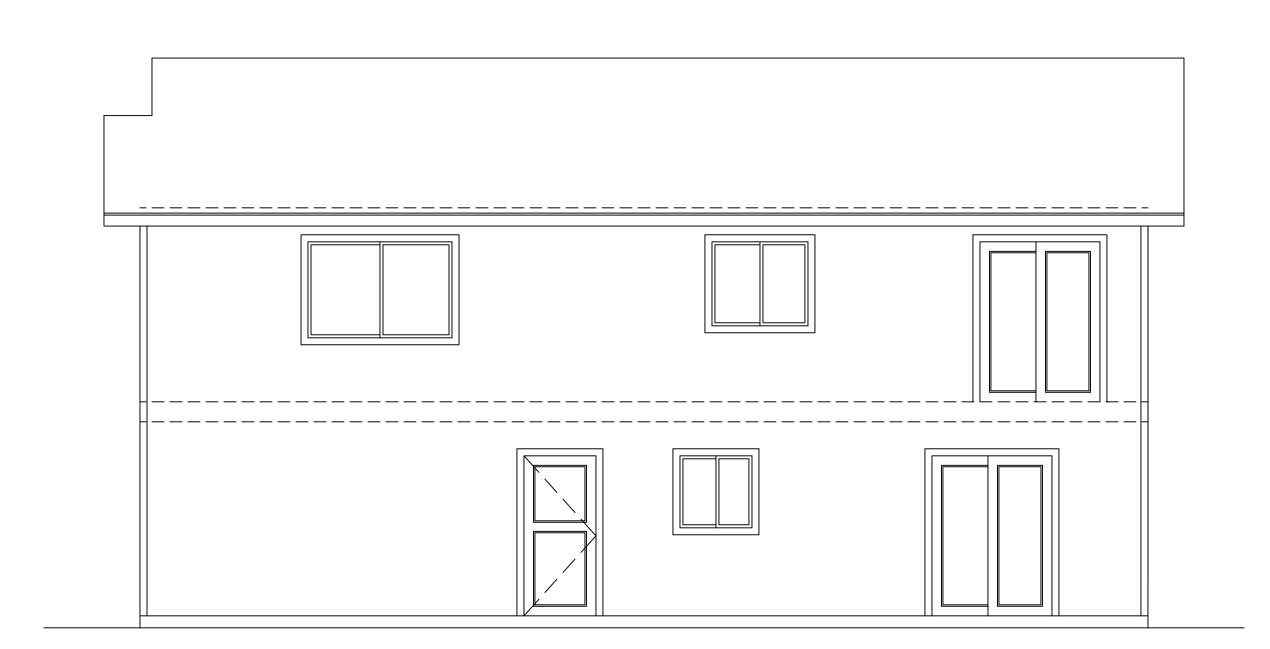


REAR ELEVATION SCALE: 1/4" = 1"

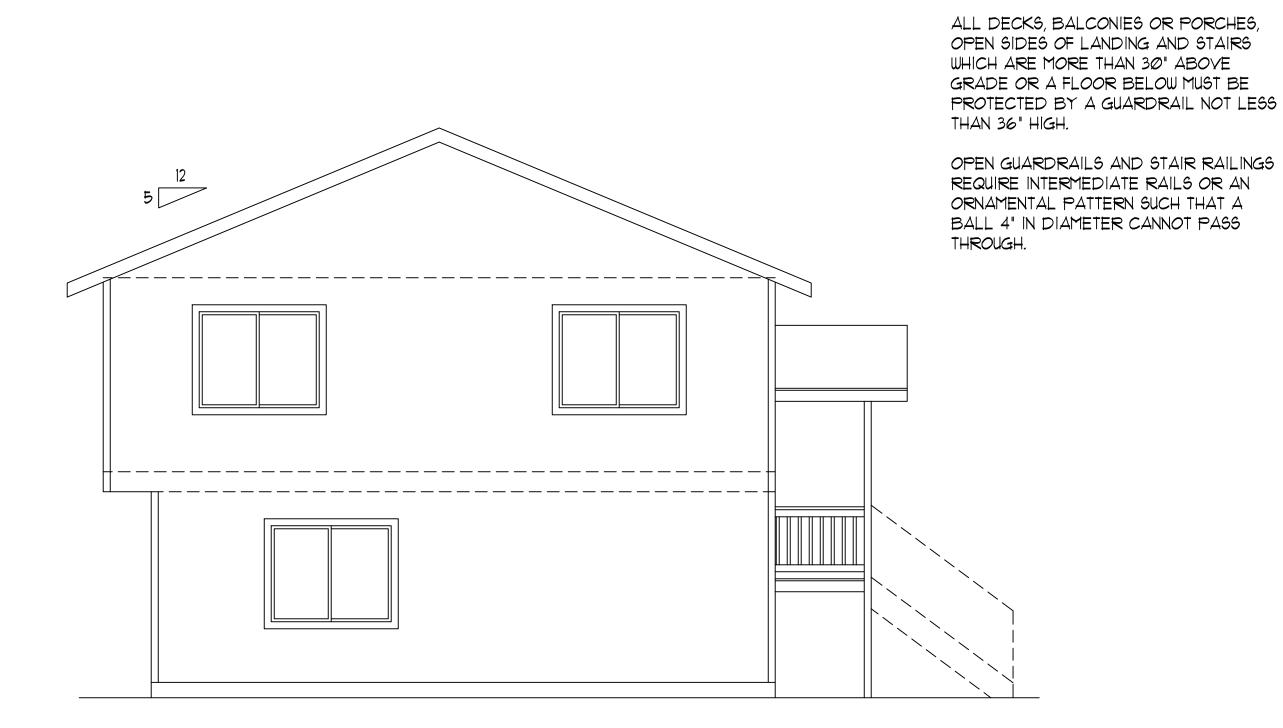

LEFT ELEVATION SCALE: 1/4" = 1'

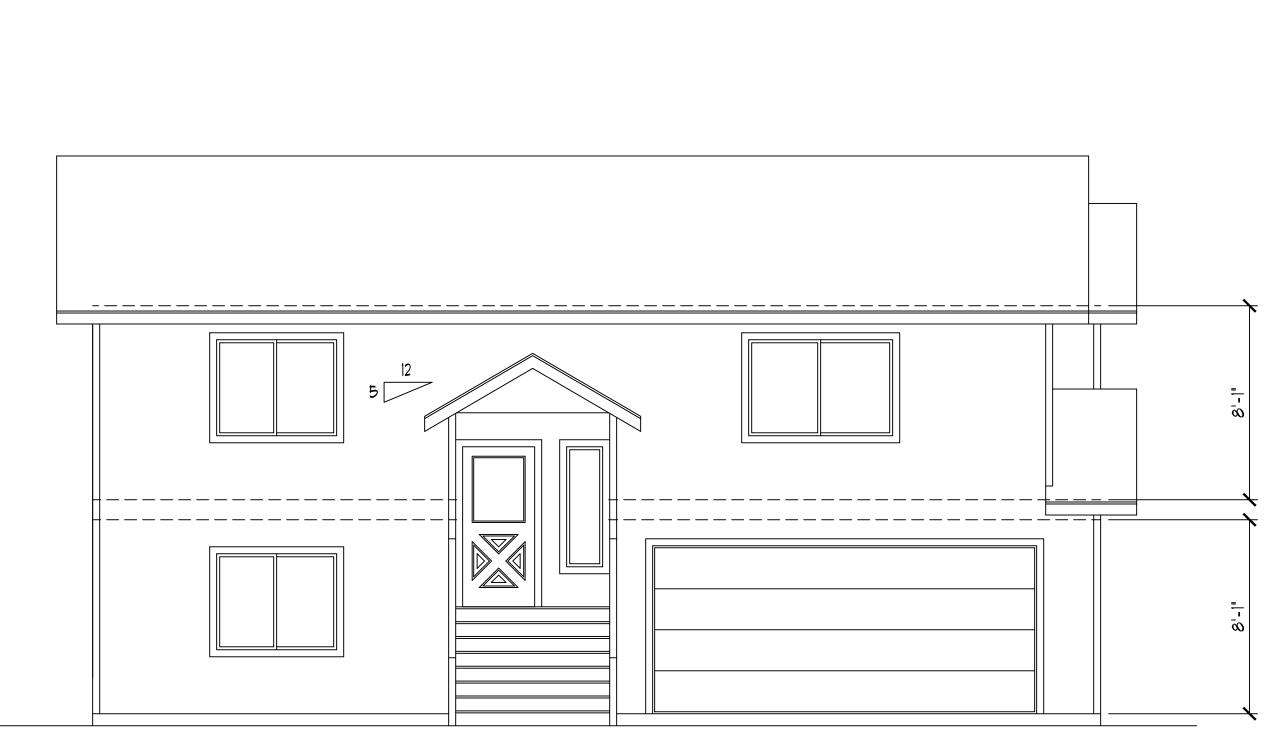

FRONT ELEVATION SCALE: 1/4" = 1"

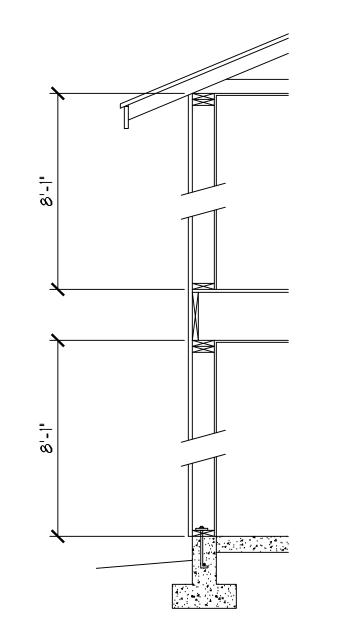

EFFICIENT WATER HEATING 5a: All showerhead and kitchen sink faucets installed in the house shall be rated at 1.75 GPM or less. All other

lavatory faucets shall be rated at 1.0 GPM or less.

EFFICIENT WATER HEATING 5c:
Electric heat pump water heater with a minimum EF of 2.0

and meeting the standards of NEES's Northern Climate

Specifications for Heat Pump Water Heaters.

HIGH EFFICENCY HVAC EQUIPMENT 3d:
DUCTLESS SPLIT SYSTEM HEAT PUMPS, ZONAL CONTROL:
In homes where the primary space heating system is zonal electric heating, a ductless heat pump system shall be installed and provide heating to at least one zone of the housing unit.

AIR LEAKAGE CONTROL AND EFFICIENCY VENTILATION 2a: Compliance is based on Table R402.4.1.2. Reduce the tested air leakage to 3.0 air changes per hour maximum AND All whole house ventilation requirements as determined by IRC Section MI507.3 shall be met with a high efficiency fan (max 0.35 watts/cfm), not interlocked with the furnace fan ventilation systems using a furnace including an ECM motor are allowed, provided that they are controlled to operate at low speed in ventilation only mode

You energy

work sheets

information does not match work sheets,

5a, 5c, 3d, and 1a in

TYP, WALL SECTION SCALE: 1/2" = 1'

CONC. SLAB FLOOR:
-4" CONCRETE SLAB
-R-10 INSUL. (IF HEATED)
-4" GRAVEL BASE
-COMPACTED SOIL

STUD WALL:

-LAP SIDING:
-HOUSE WRAP

-15# F

-16" O.S.B. SHEATHING:


-1/6" O.S.B. SHEATHING -2×6 STUDS @ 16" O.C. -R-21 INSULATION -1/2" G.W.B. WOOD JOIST FLOOR:
-FINISH FLOORING
-34" O.S.B. SUB-FLOOR
-JOIST SYSTEM @ 16" o.c
-R-38 INSUL. (IF UNHEATED BELOW)

WOOD ROOF: -COMP. ROOFING: -15# FELT: -16" O.S.B. SHEATHING: -MFR. TRUSSES @ 24" O.C. -R-49 INSULATION


-1/2 " G.W.B.

LOT / OWNER ROD FORSBERG 360-271-4808 c MAILING: 8018 WENATCHEE PL NW SILVERDALE, WA 98383 TAX ID# DRAWN BY SCOTT SHELTON PLANSGUY® OUTLOOK.COM (360)620-8883 c DATE 12/17/19 REVISED DRAWING: ELEVATIONS

Permit Number: 19-05696

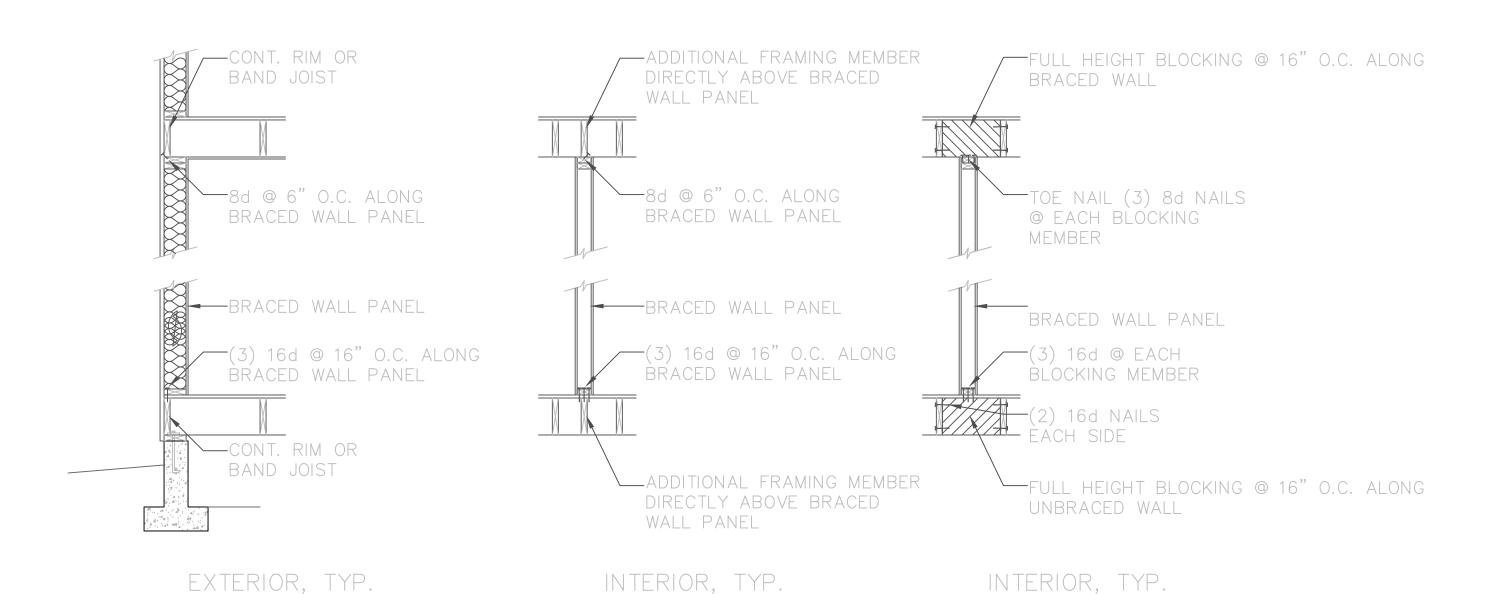



1 BRACED WALL PANEL CONNECTION WHEN PARALLEL TO FLOOR/CEILING FRAMING

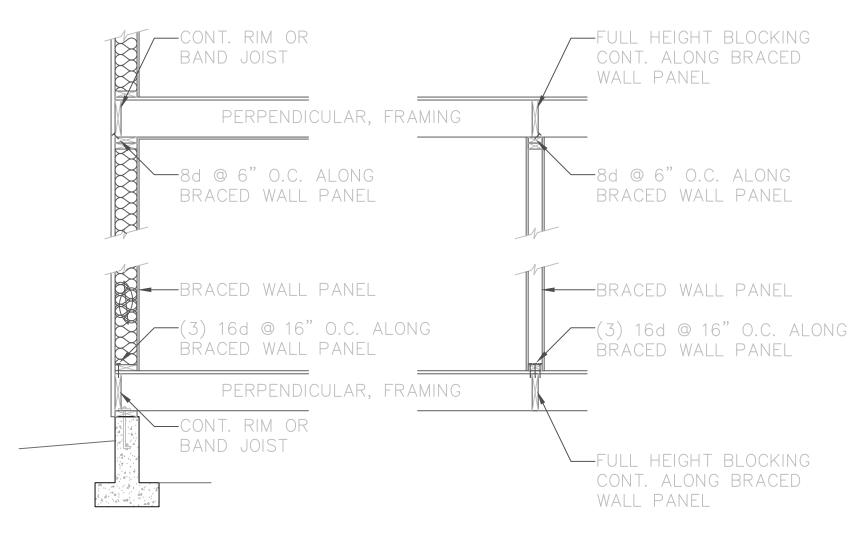

EXTERIOR, TYP. INTERIOR, TYP.


2 BRACED WALL PANEL CONNECTION WHEN PERPINDICULAR TO FLOOR/CEILING FRAMING

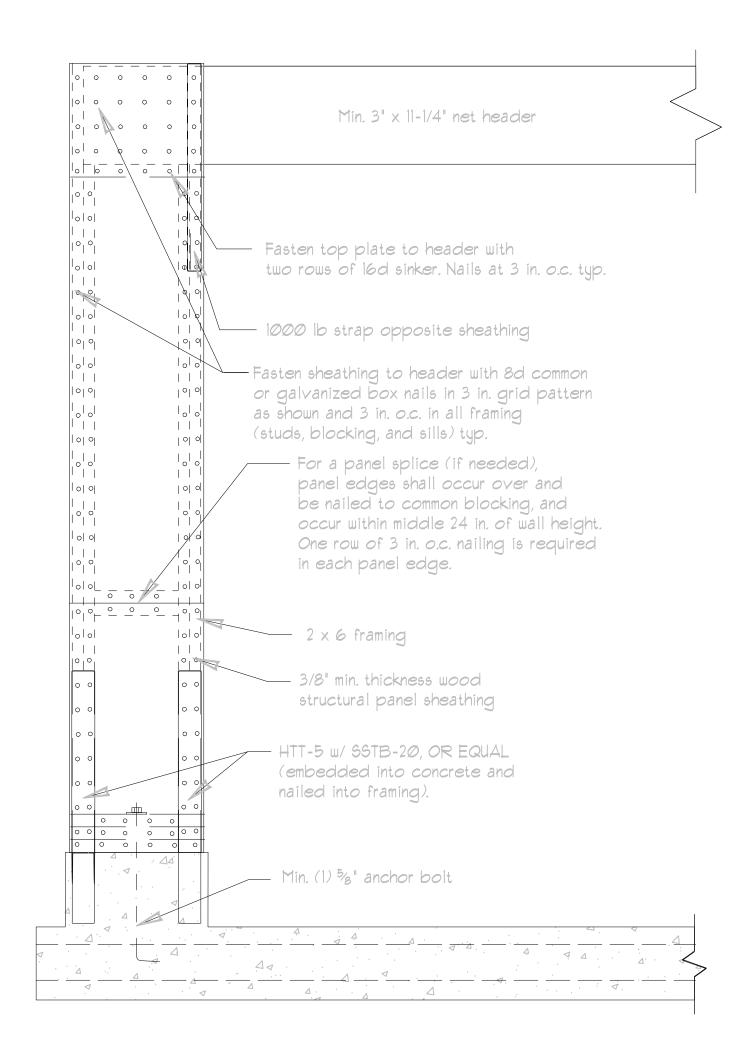

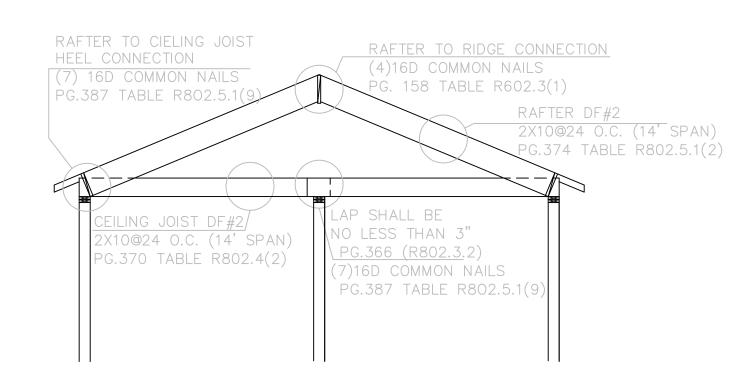

RAFTER & CEILING JOIST DETAIL SCALE: 1" = 1"

## TYP, PFG DETAIL SCALE: 1" = 1"

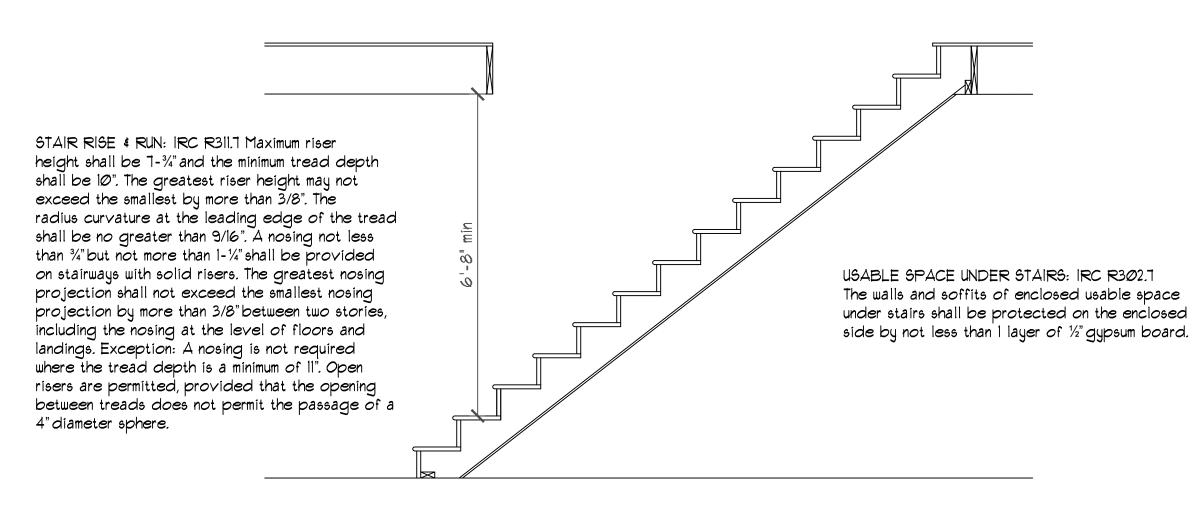

STAIRWAYS: IRC R311.7 Private dwelling stairways shall not be less than 36" in width and shall have a headroom clearance of not less than 6'-8" measured vertically from the sloped plane adjoining the tread nosings, or landing surfaces.



